


SITE PLAN
SCALE-1"=16'-0"

TION

MONMATA HALL
11 STD BUILDING

OPENTLAND SUB PLANNING

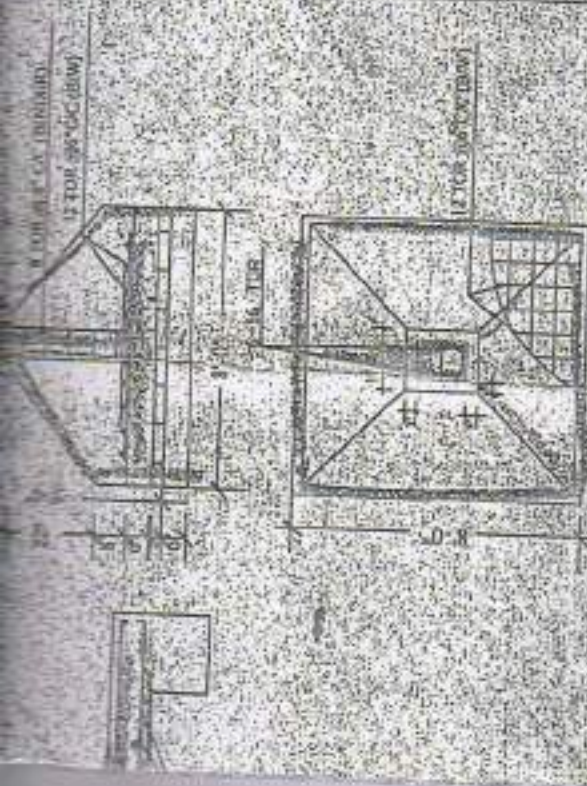

DETAILS OF COLS. FOUNDATION

SCALE: 1/4" = 1'-0"



- 1. R.C.C. WORK IN COL, LINTEL ETC. WITH REINFORCED AS PER DESIGN
- 2. 1 1/2" DIA. FLOOR WITH P.C.C. (1:2:4) & FINISH
- 3. 1 1/2" TH. PLASTERING WITH C.MOKER (6:1) BOTH SIDE OF MAIN WALL
- 4. 1 1/2" TH. PANNEL SHEET FOR DOOR & WINDOW
- 5. 10" TH. C.BICK WORK IN SOAIC PIT
- 6. 2 COATS OF SNOG/CHEM WASHING & 2 COATS OF SYNTHATIC ENAMAL
- 7. 4" DIA. C.R.W DOWN PIPE
- 8. SUN SHED & LINTEL AS PER SCALE
- 9. WRITEN DIMENSION TO BE FOLLOWED
- 10. ALL DIMENSION ARE IN FT & INCH
- 11. CAR PARKING WILL BE ALLOTTED ONLY TO BE RELATED OWNER NOT TO BE OUTSIDER

S.A.E.

TECHNICAL INFORMATION

- 1. AREA OF LAND = 4497.67 SFT (MORE OR LESS)
- 2. PROP GR. FLR COMM. AREA (STAIRS) = 22.22 SFT (TOT) = 195.89 SFT
- 3. 2301.25 SFT FOR CAR PARKING
- 4. PROP 1ST FLR COVERED AREA = 197.74 SFT
- 5. PROP 2ND FLR COVERED AREA = 2097.14 SFT
- 6. PROP 3RD FLR COVERED AREA = 2457.14 SFT
- 7. PROP 4TH FLR COVERED AREA = 2492.14 SFT
- 8. PROP 5TH FLR COVERED AREA = 2497.14 SFT
- 9. TOTAL COVERED AREA = 2681.59 SFT
- 10. % OF GROUND COVERAGE = 52.76%
- 11. PROP. T.A.R. = 3.68

FLAT AREA:

- FLAT "A" COVD. AREA = 572.55 SFT.
- FLAT "B" COVD. AREA = 638.57 SFT.
- FLAT "C" COVD. AREA = 556.94 SFT.
- FLAT "D" COVD. AREA = 556.44 SFT.
- COMM. SPACE COVD. AREA = 173.67 SFT. (STAIR)
- TOTAL COVD. AREA = 2497.14 SFT.

CAR PARKING SPACE:-


- 1. PERMISSIBLE NO. OF CAR PARKING = 5 NO
- 2. PROPOSED NO. OF CAR PARKING = 7 NO

SCHEDULE OF DOORS & WINDOWS :-

DOORS	WINDOWS
D=3'-0" X 6'-6"	WI=4'-0" X 4'-0"
DI=2'-6" X 6'-6"	V=2'-0" X 2'-0"

SIGNIFICANCE :-

- OWNER LAND SHOWN IN COLOUR :-
- EXISTING CONSTRUCTION SHOWN IN COLOUR :-
- PROPOSED CONSTRUCTION SHOWN IN COLOUR :-

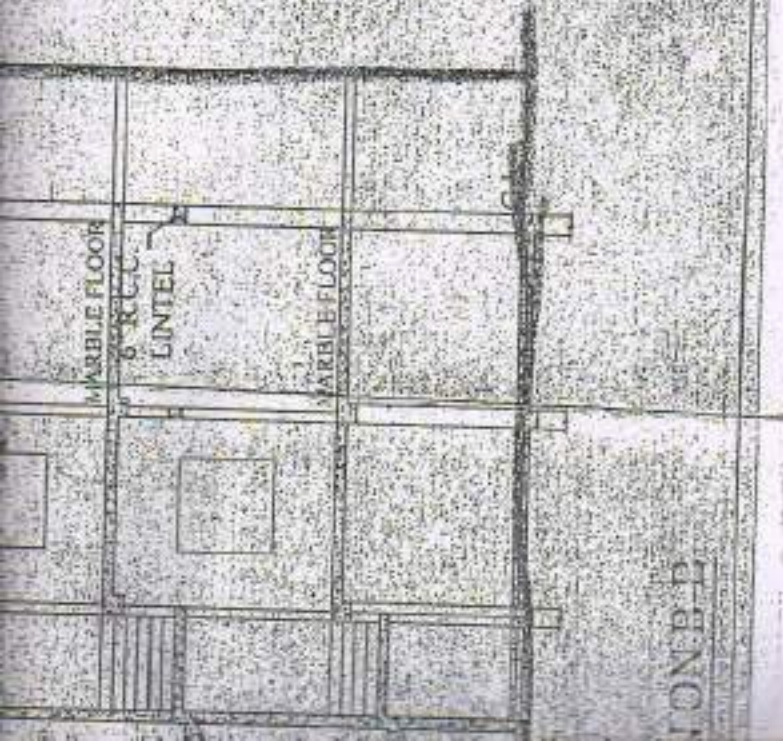

10NBP

22/10/16
Chairman
Burdwan Municipality

VICE-CHAIRMAN

22/10/16

ENGINEER

✓ Any Power

Expend. Days

Monetary Date


22/10/16

HEALTH OFFICER

Sceminal Ghosh

DRAWN BY

SIG. OF OWNER

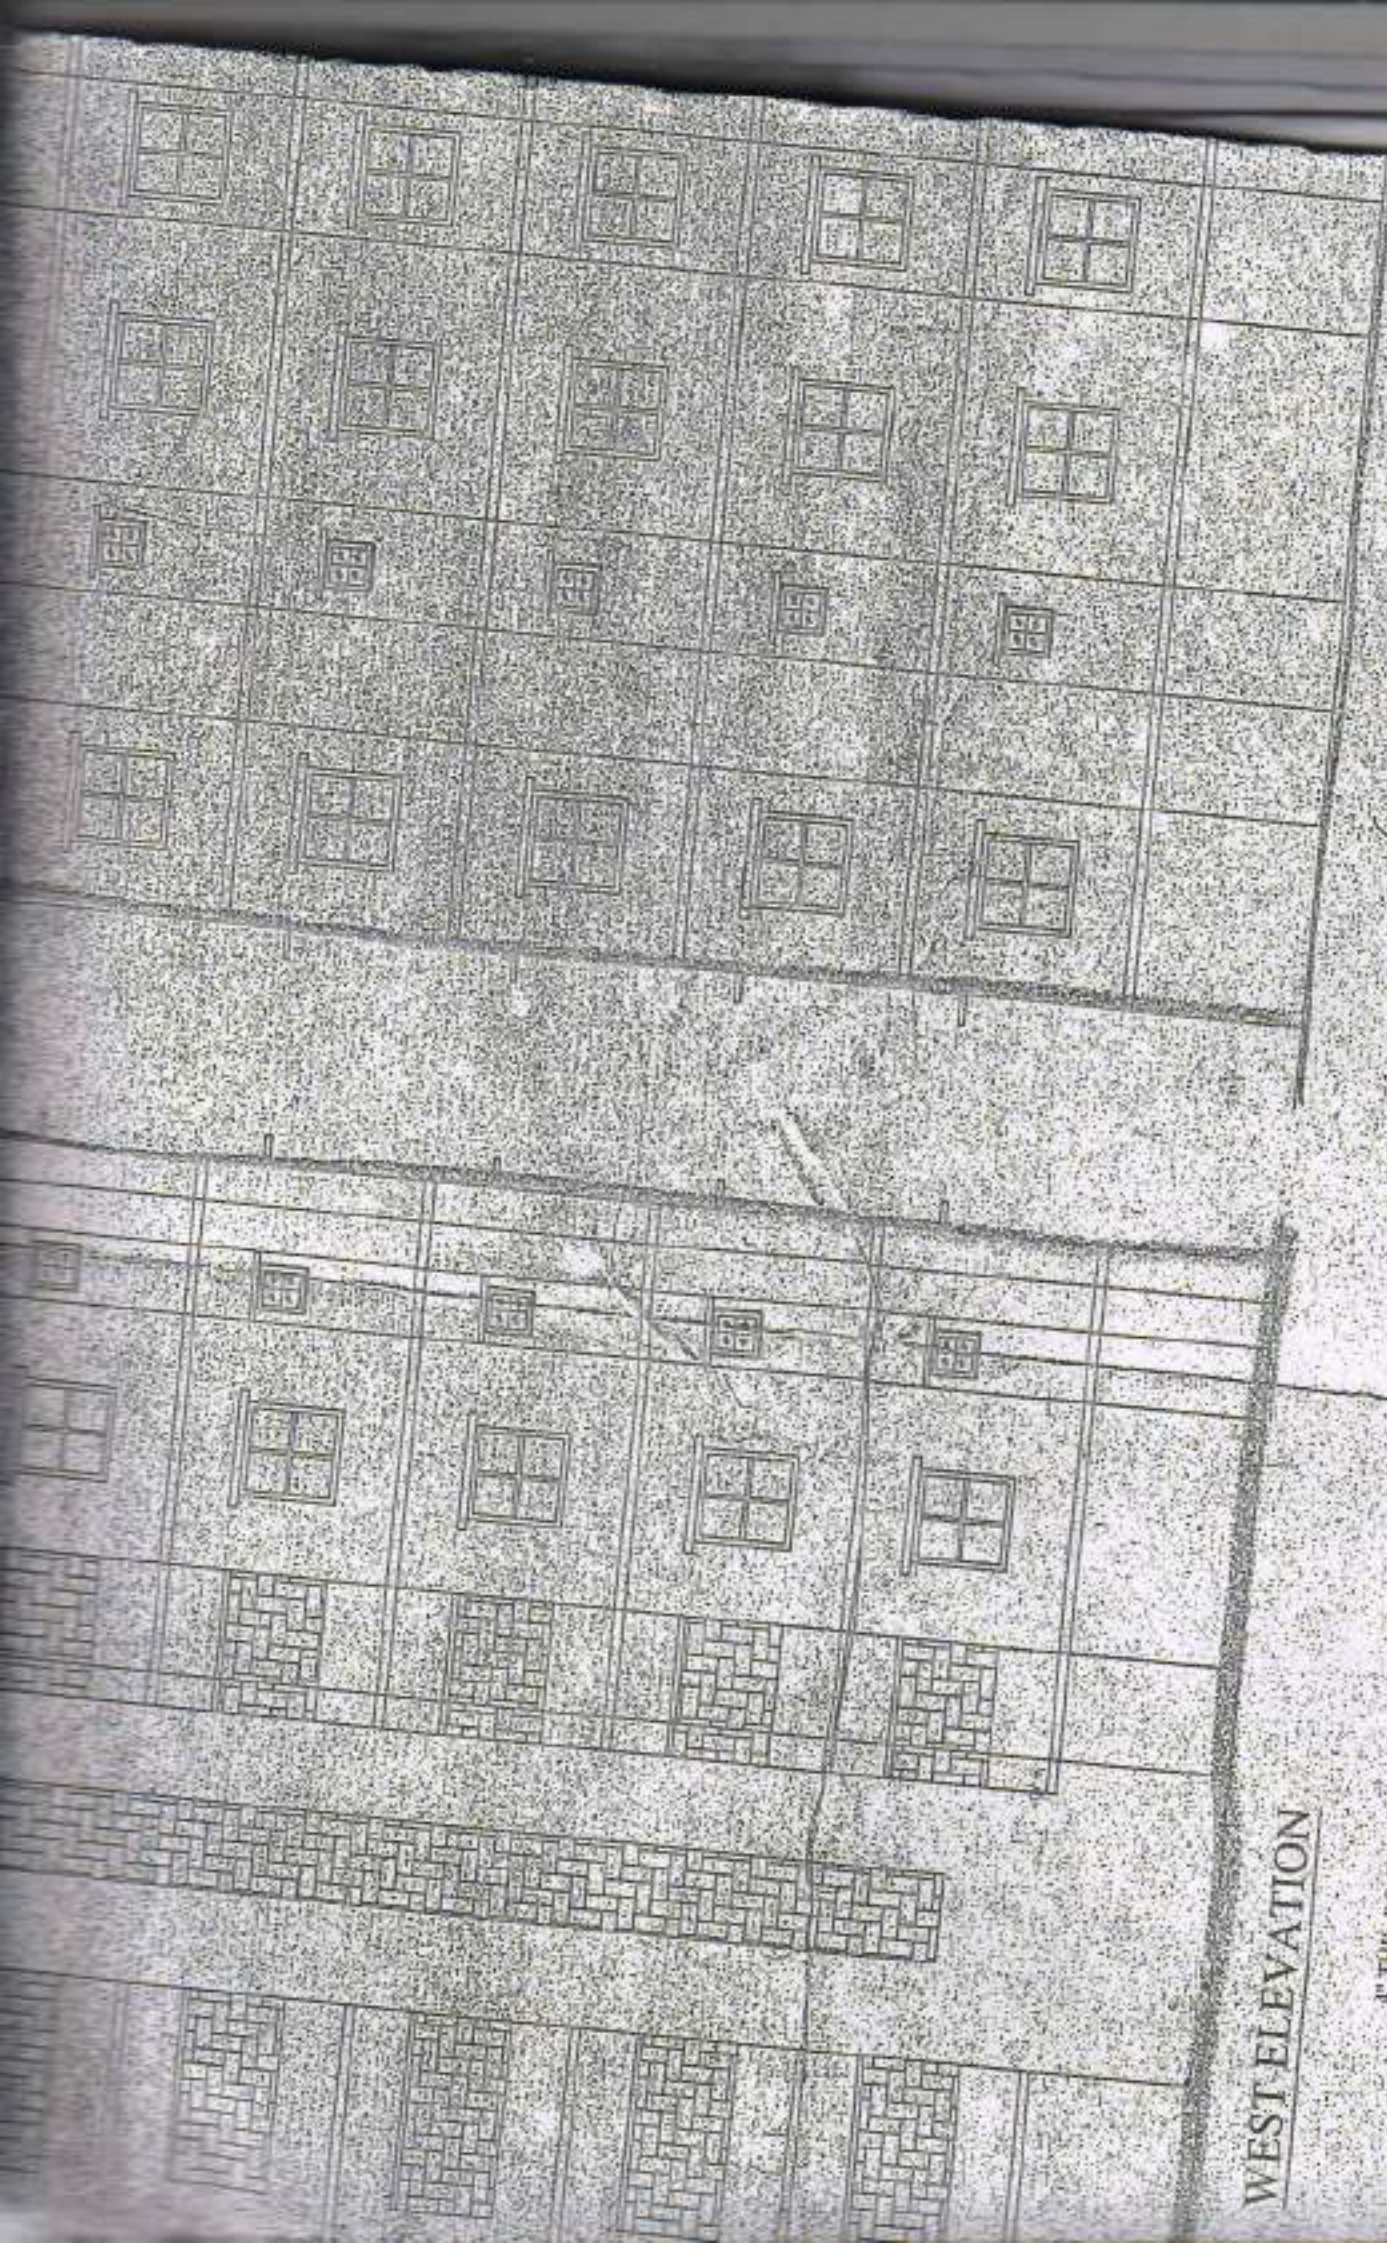

SOUTH ELEVATION

WEST ELEVATION

4" THK. R.C.C. SLAB

MANHOLE COVER

4" THK. R.C. SLAB

1'-0" DIA. MANHOLE COVER

OUTLET 1'-3" G.L.

2'-0"


G.L.

GAP FILLED
BY COURSE SAND
BRICK BATS
HONEY-COMB
BRICK WORK




DETAILS OF ROOF SLAB



(SCALE: 1" = 2'-0")

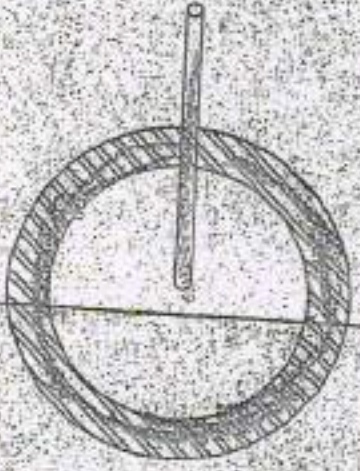


SECTION AT XX

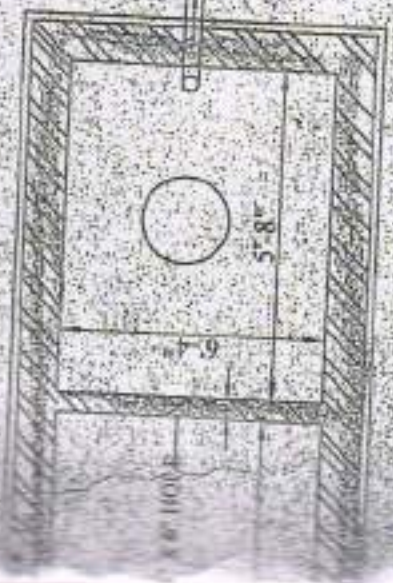


TANK & SOAK PIT (50 USERS)
 CE: 1" = 4'-0"

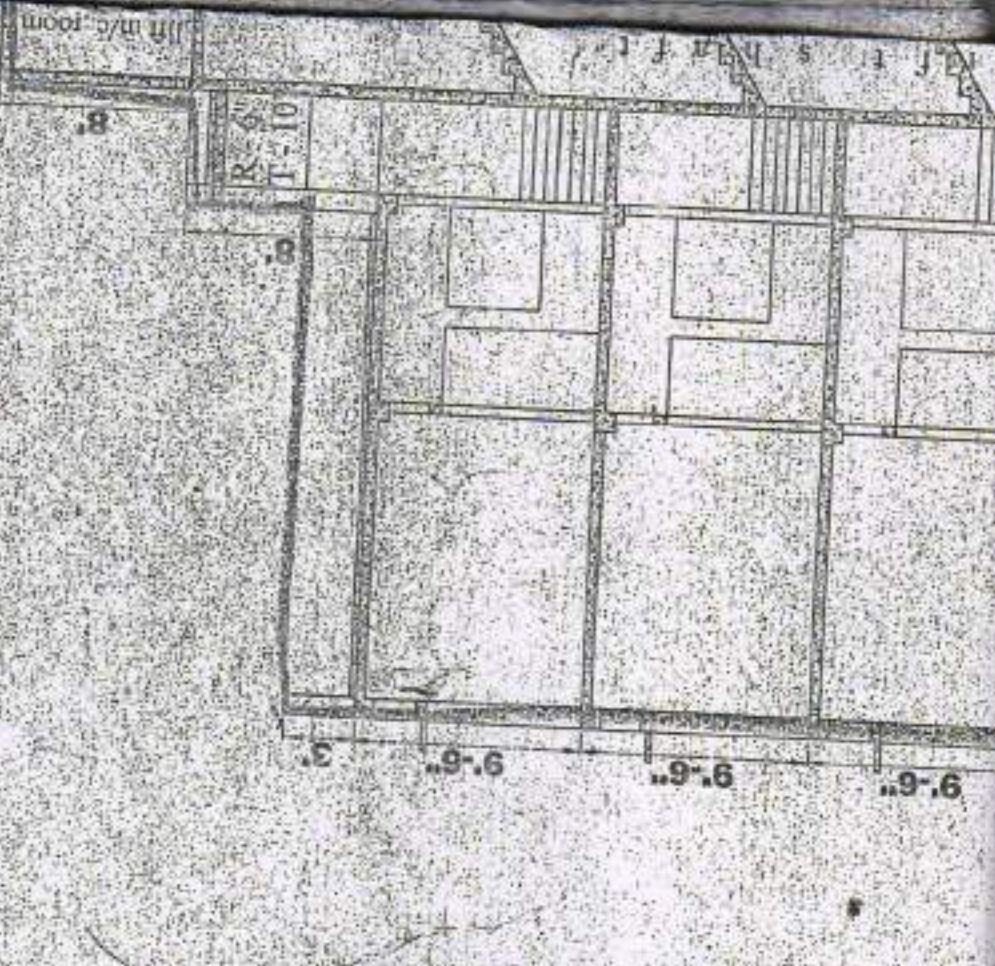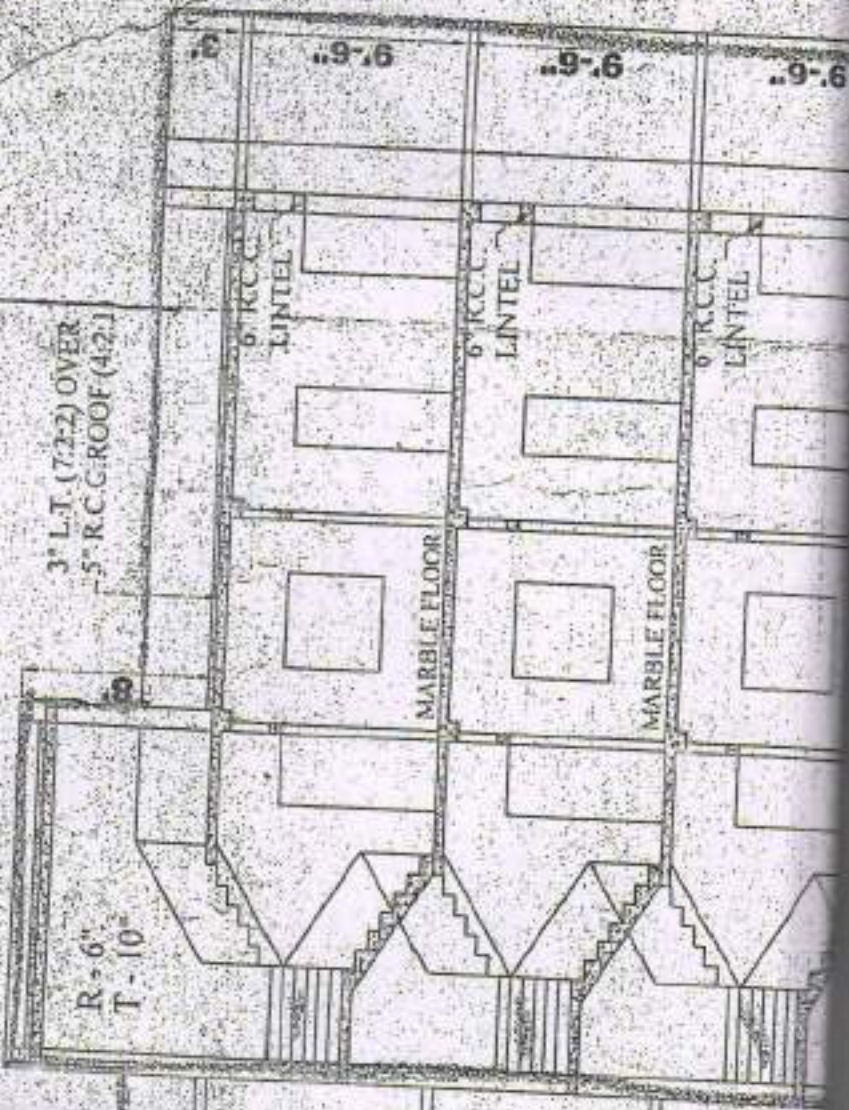

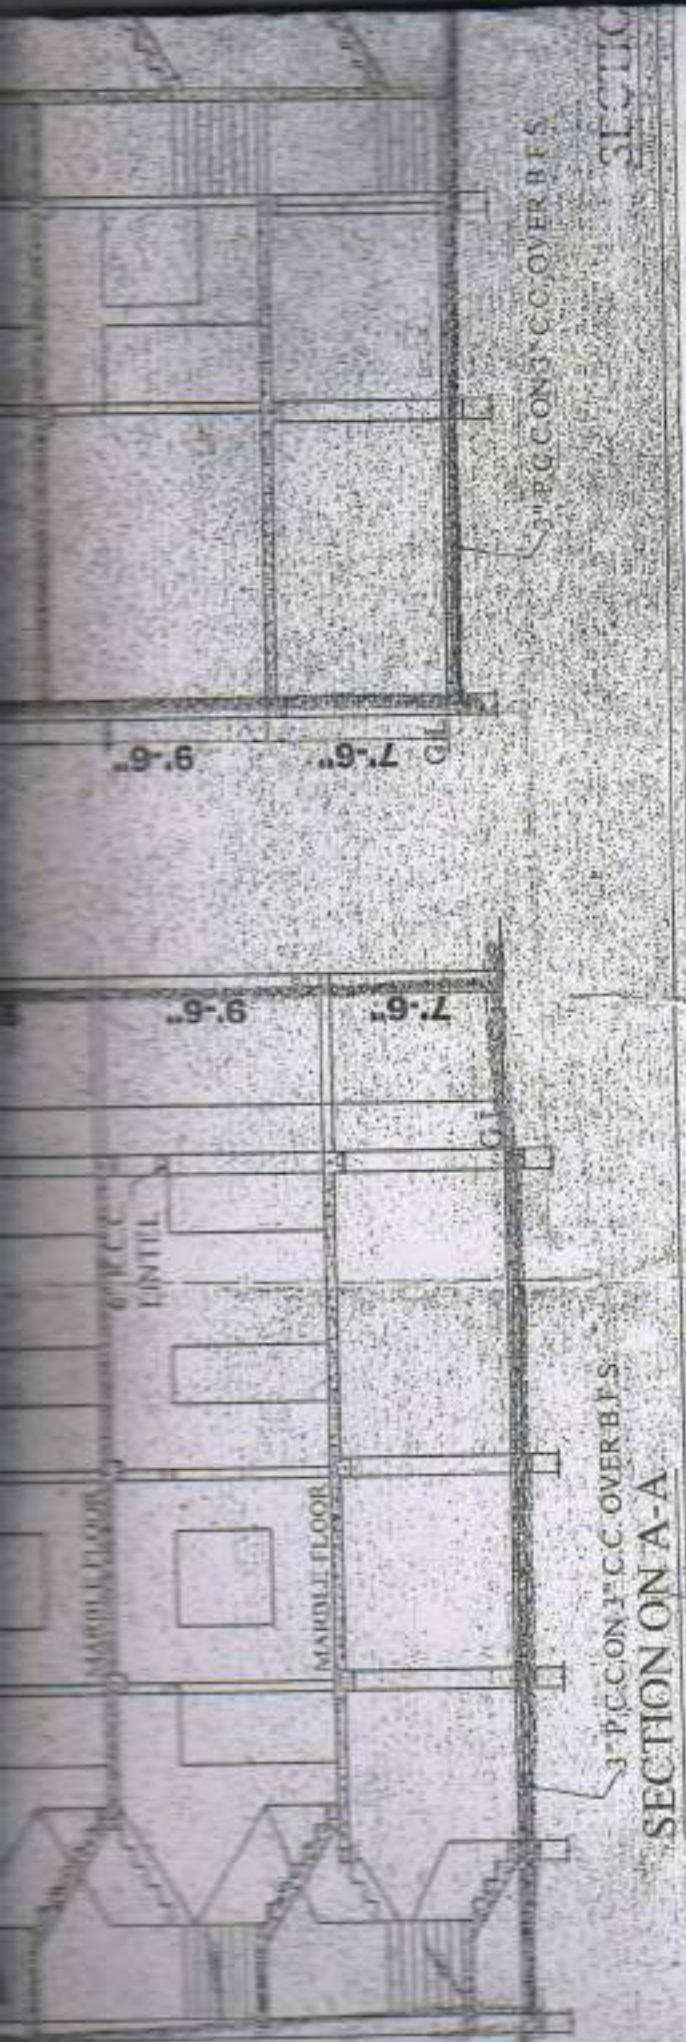

PLAN FOR THE PROPOSED G+V STORED RESIDENSIAL FLA
DUTTA, 2) SMT. JAYEETA DEY W/O SRI ARNAB DEY, 3) MOI
, J.L. NO:-30, R.S. PLOT NO.:-522, 490, L.R. PLOT NO:-3081, 3082, I
NO-32, WARD NO:-25, P.S.:-BURDWAN, DIST.- PURBA BARDI

SCALE

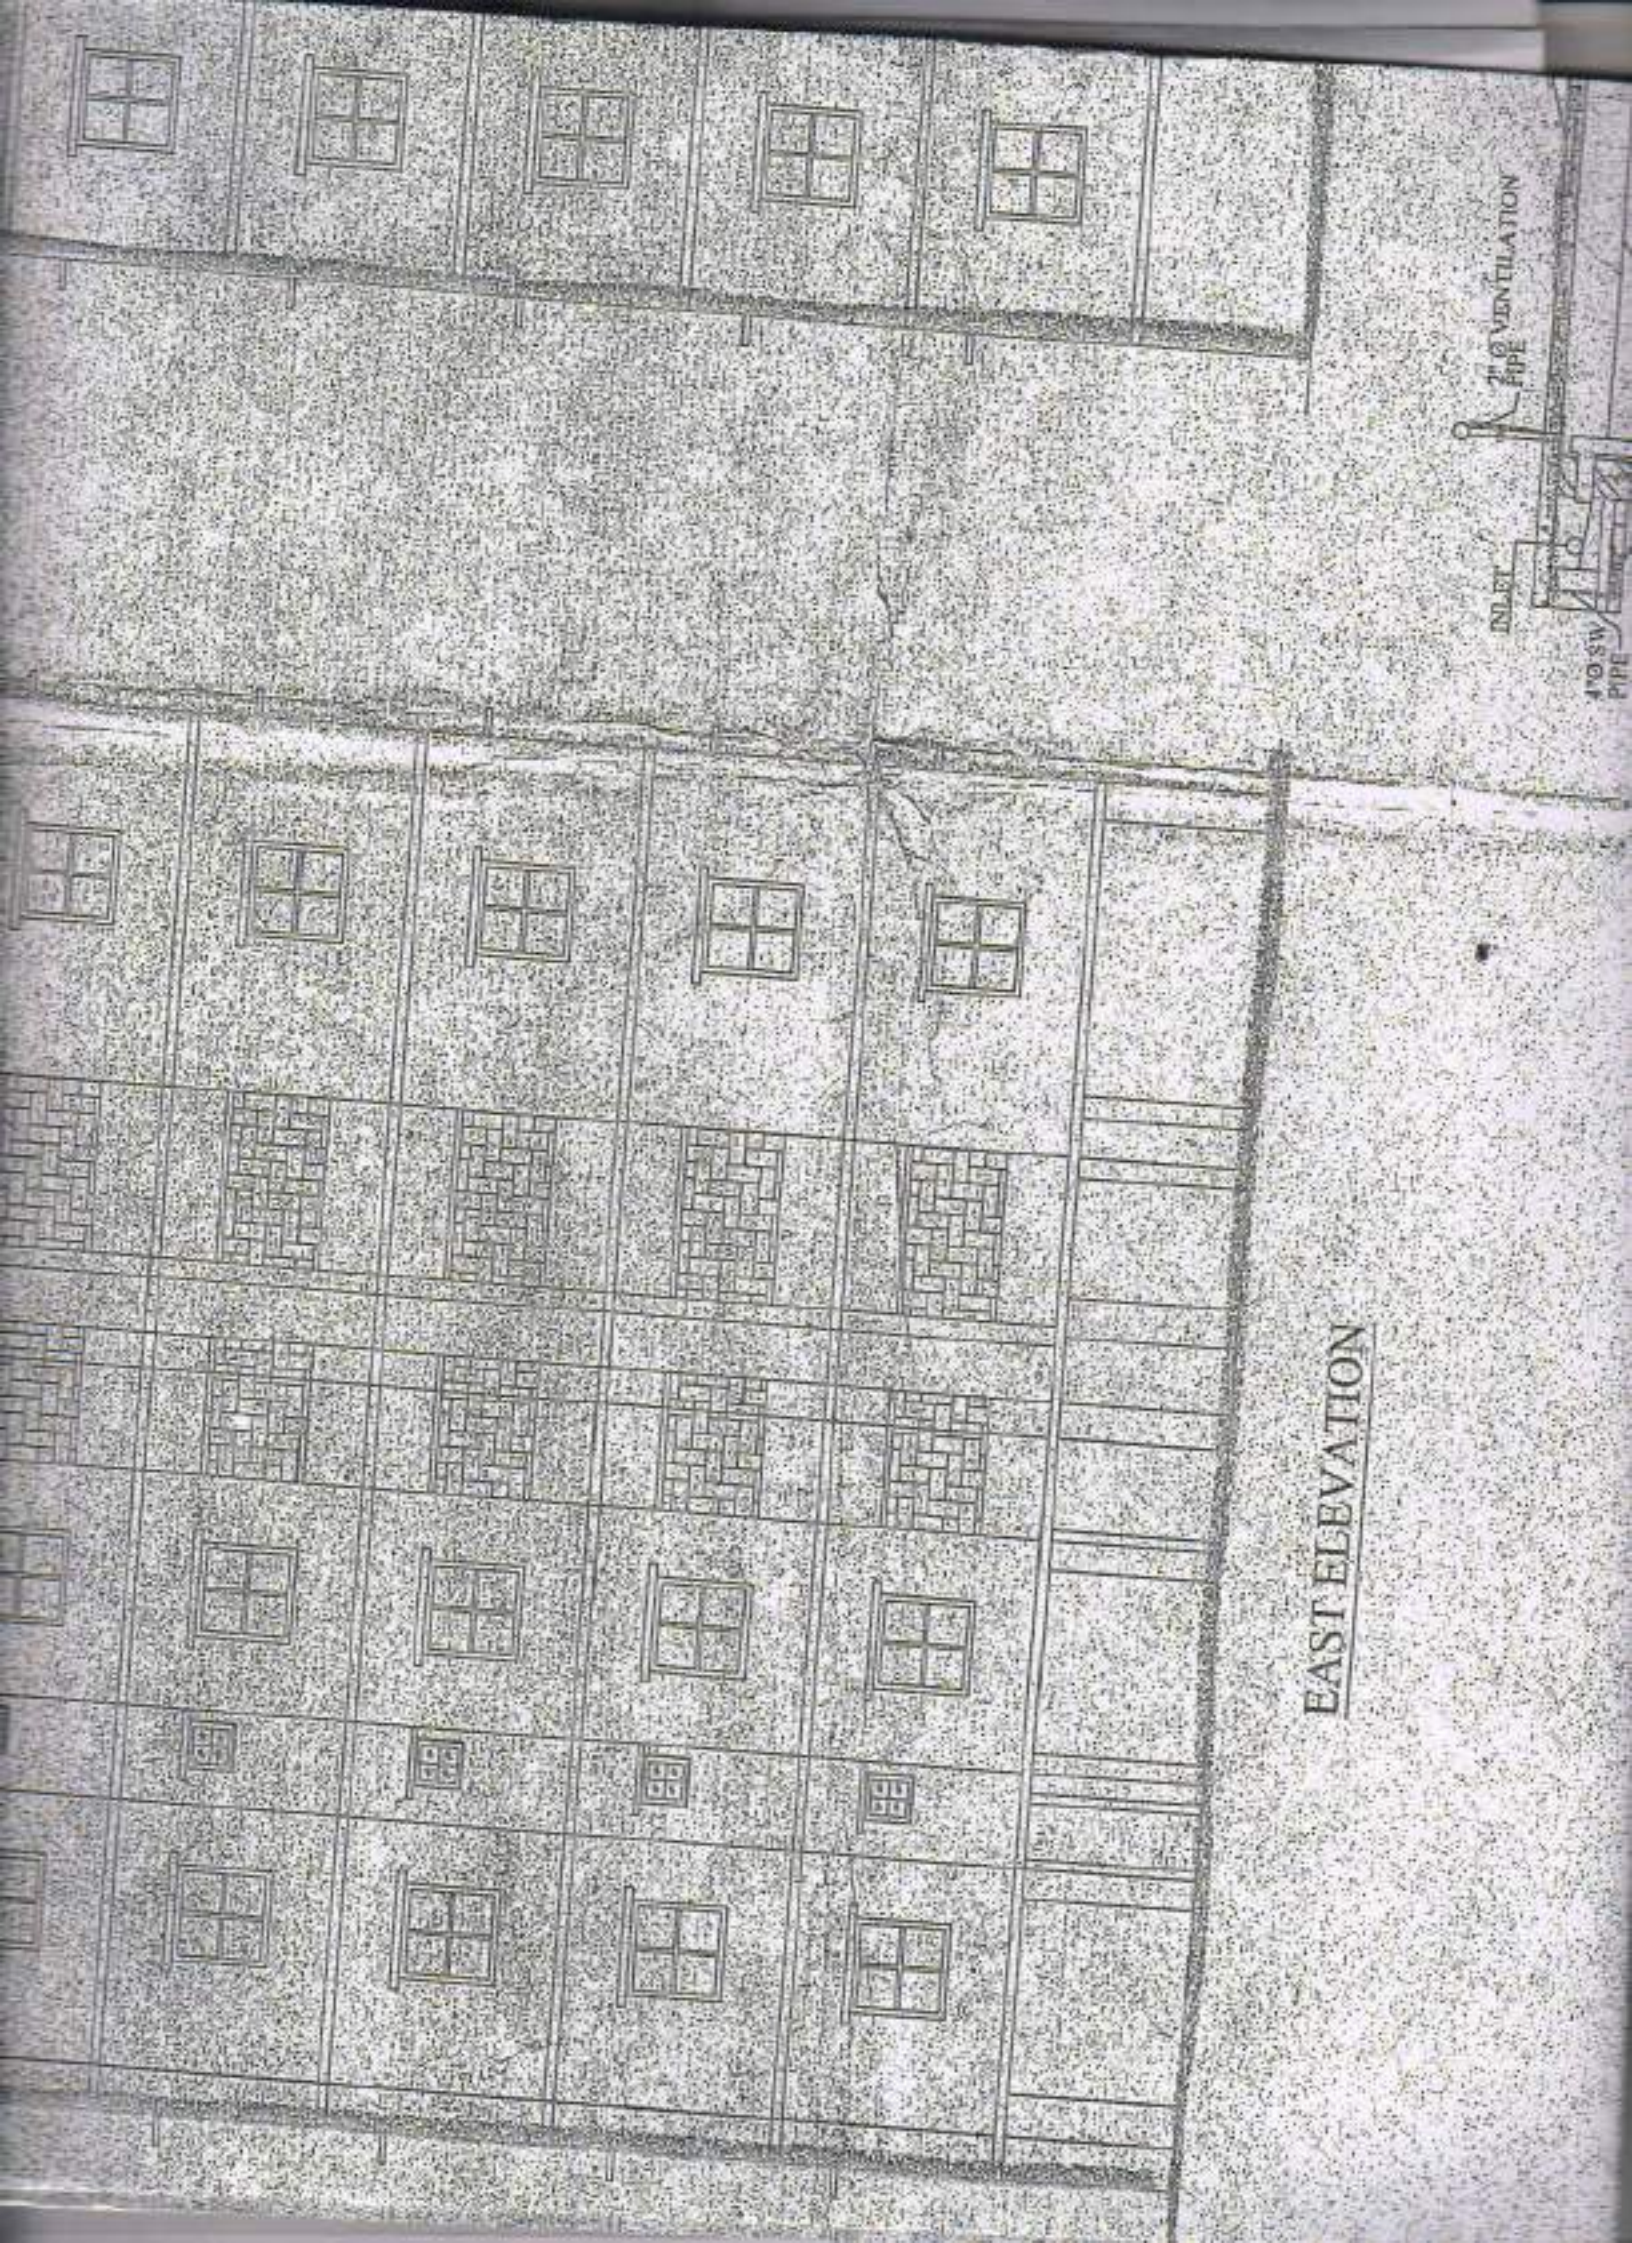

7" Ø VENTILATION PIPE

INLET

4" Ø SW PIPE

EAST ELEVATION

T NO. 1225


SECTION-YY




PLAN OF SUG. WATER RESERVOIR
SCALE 1"=4'-0"

1.50 TH. P.C. COVER
75 TH. F.B.S.

4" THK. R.C.C.
3" THK. P.C.
3" THK. B.F.S.

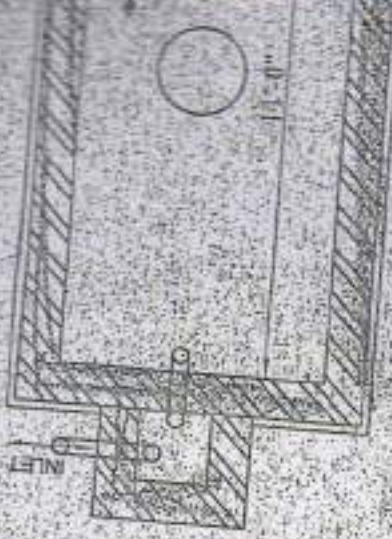



DETAILS OF SEPT
SCALE 1"=1'-0"

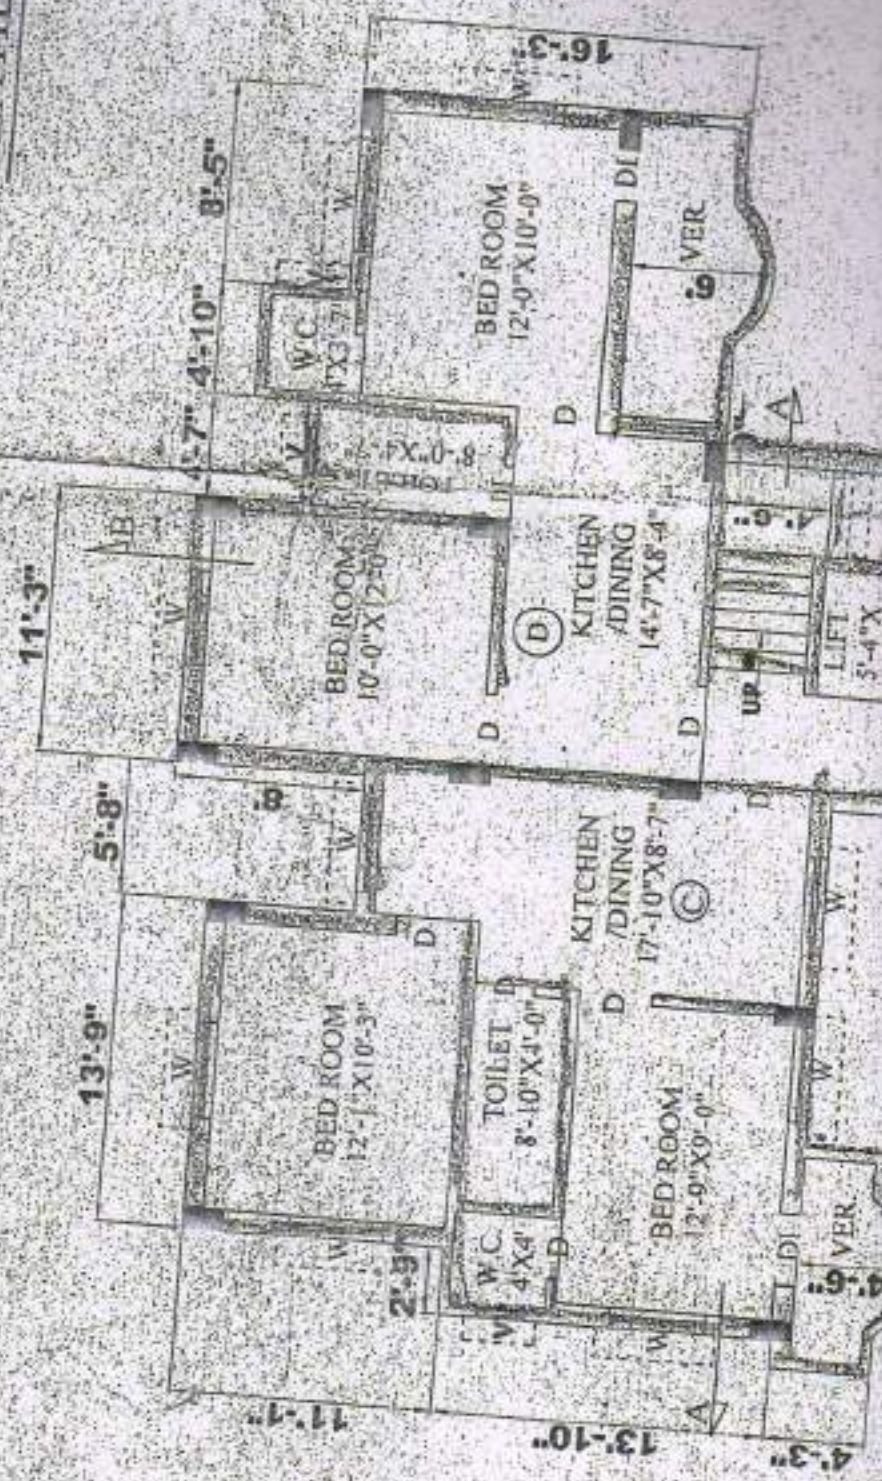

II STD BUILDING OF
MONIMALA HALDER & ORS

TYPICAL FLOOR PLAN (1ST, 2ND, 3RD, 4TH, 5TH)

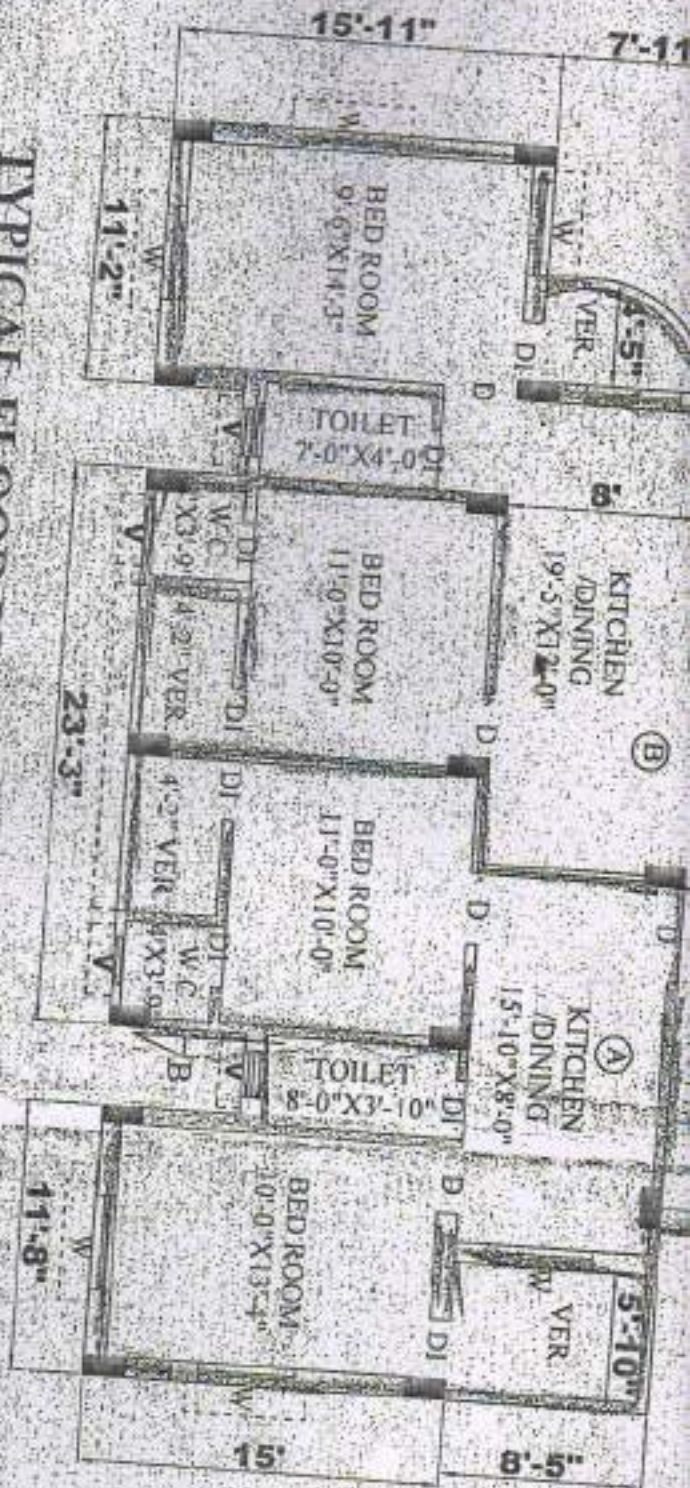

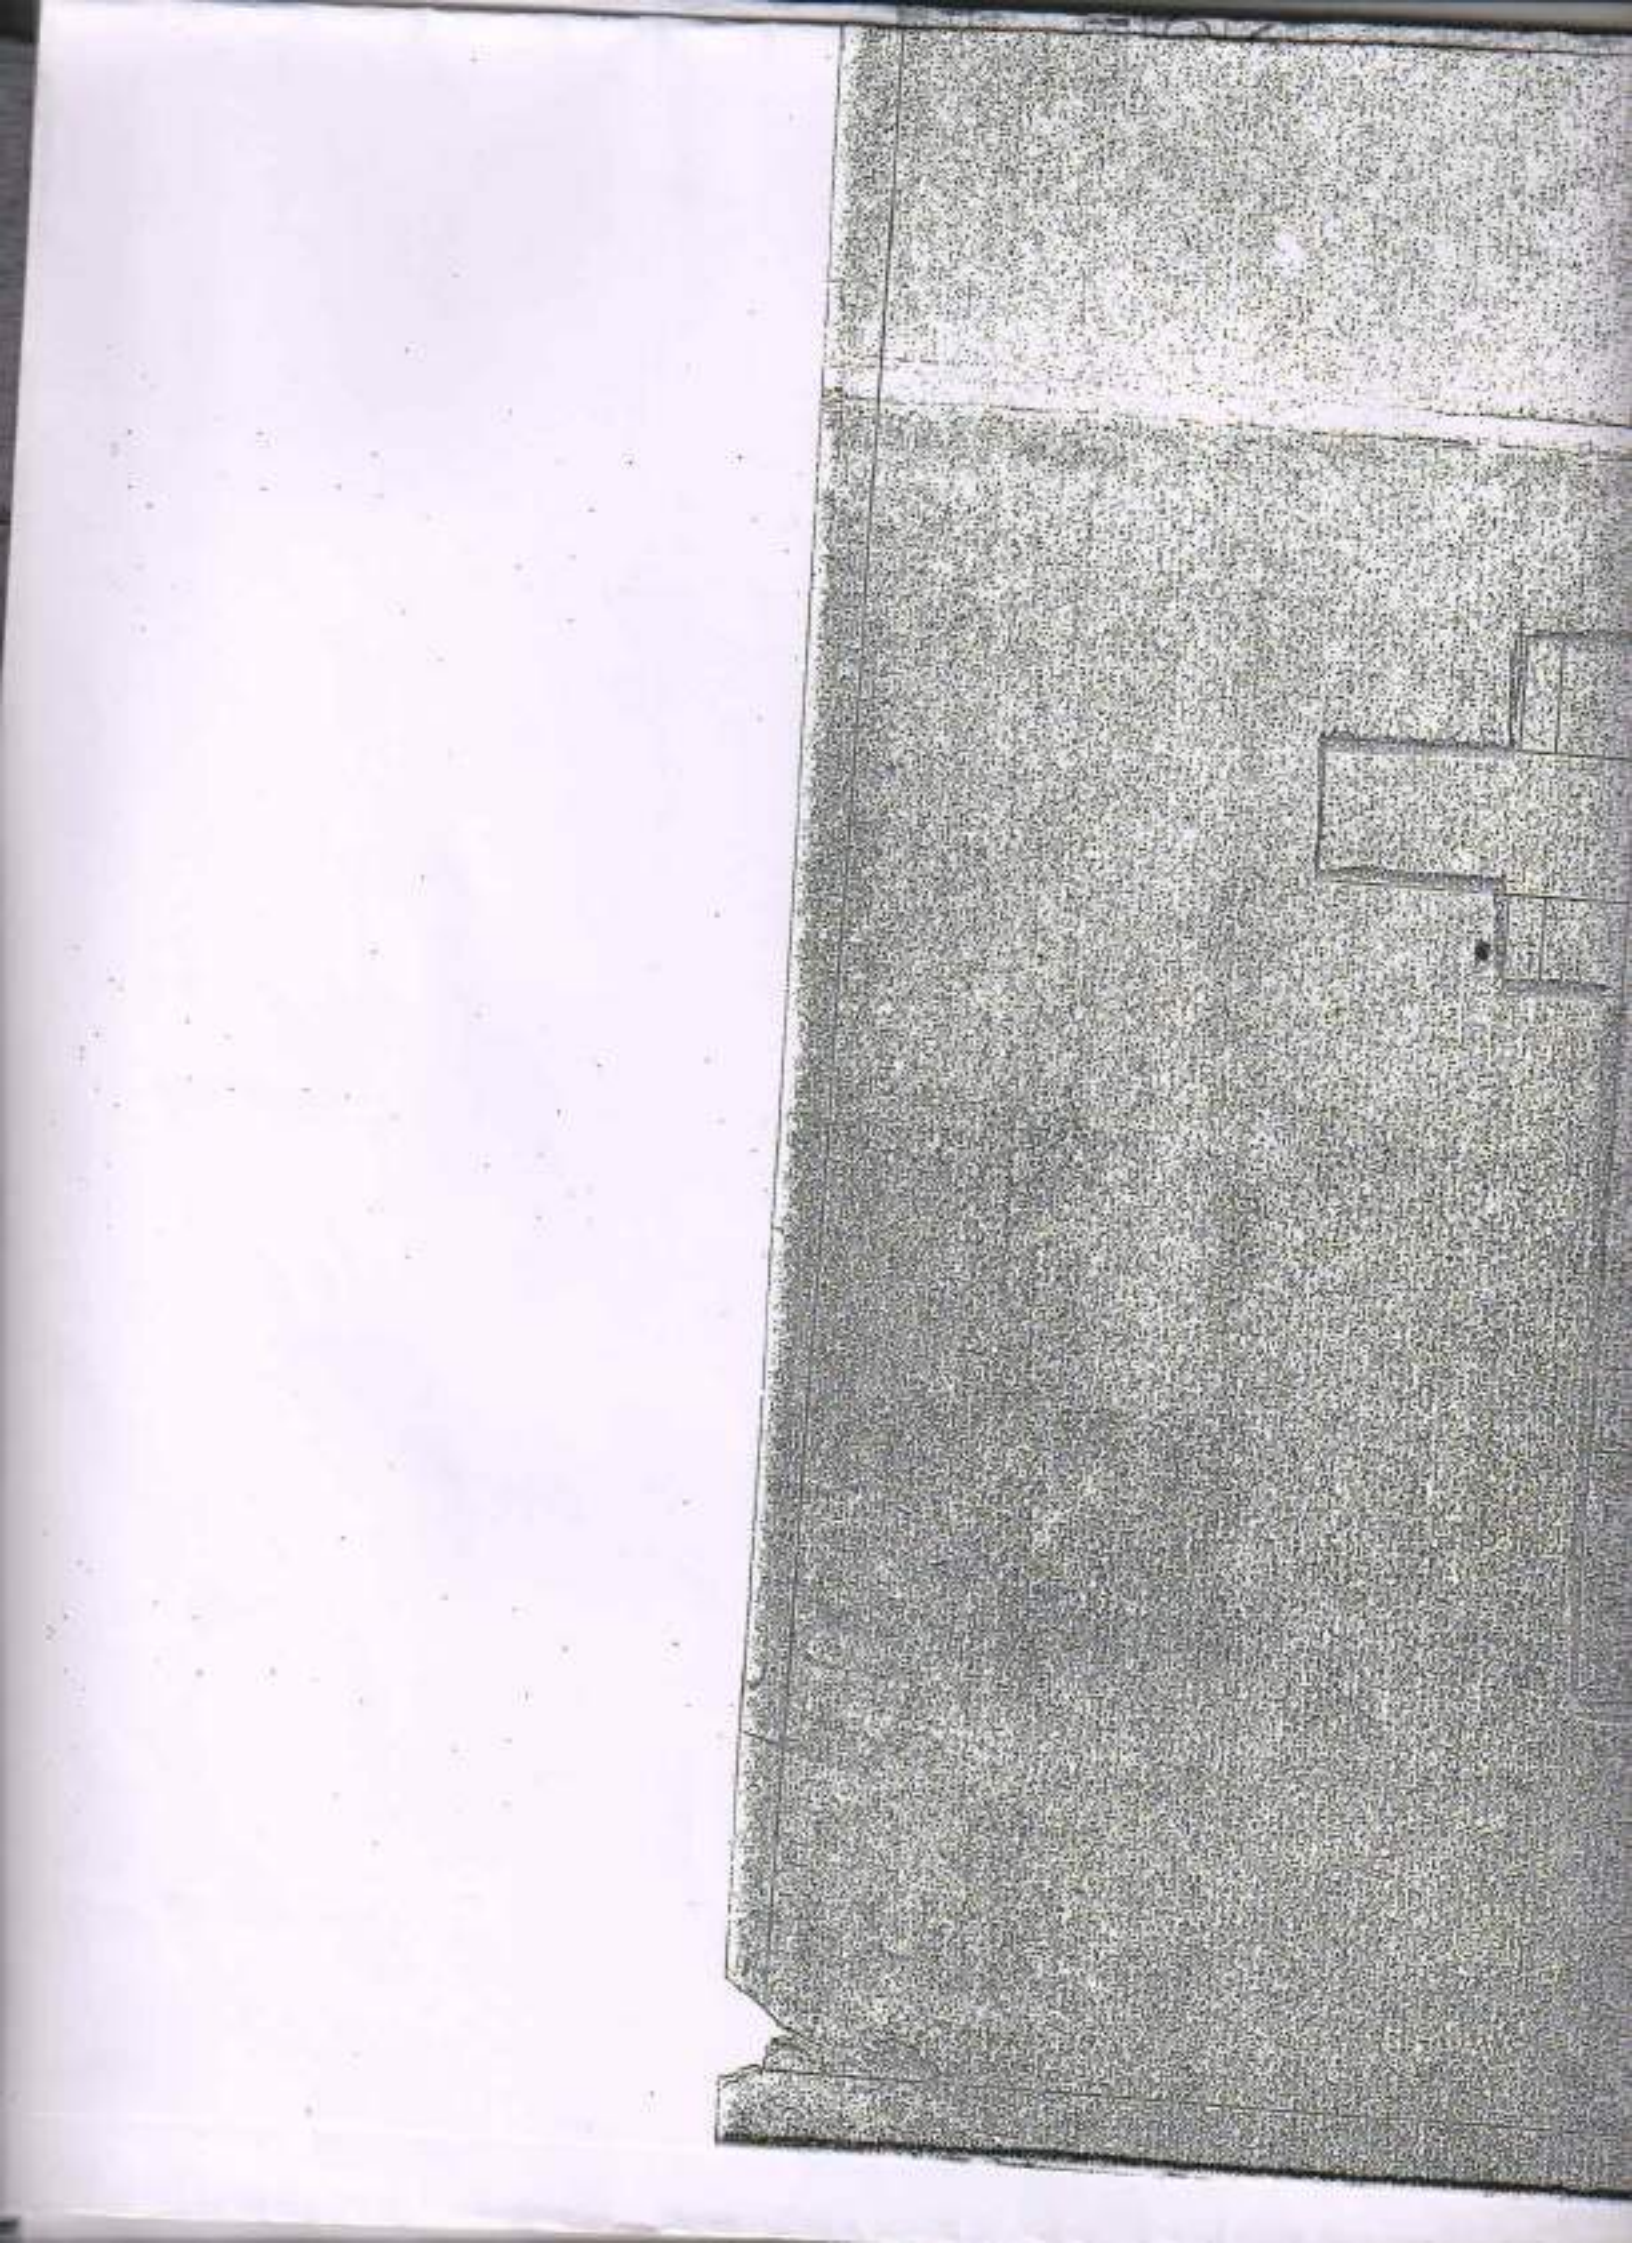



NORTH ELEVATION

